

Welcome to the whānau.

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NEW DWELLING FOR: BARRETT HOMES (CENTRAL OTAGO) LTD

ADDRESS:

LOT 547 WOOING TREE, STAGE 3C, CROMWELL





	Project No:	WT547 ^{Designed:}	CS Wind:	-	Drawing: COVER SHEET	Date:	22/02/2023
	Plan:	WT547 ^{Drawn:}	- EQ:	-	^{Client Name:} BARRETT HOMES (CENTRAL OTAGO) LTD	Rev:	
	Version:	1.0 Checked:	CJ Exposure:	-	Site Address: LOT 547	Sheet:	
Barrett Homes		design@barretthome	s.co.nz	CODC	WOOING TREE, STAGE 3C, CROMWELL	Scale:	

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Panel cladding - JH Axon (400) panel cladding - Karaka



Natural cladding - JSC Vertical Knotted Cedar w/board cladding - J56 profile







Natural cladding -Vertical Cedar w/board cladding

*The above materiality is for look & feel purposes only

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	Plan:	WT547	Drawn:	EQ:	-	BARRETT HOMES (CENTRAL OTAGO) LTD	Rev:	
	Version:	1.0	Checked: C	J Exposure:	-	Site Address: LOT 547	Sheet:	
rett Homes		design@	Dbarretthomes.co.nz	Council:	CODC	WOOING TREE, STAGE 3C, CROMWELL	Scale:	

Roofing - PCC Zinacore roofing - Trapezoidal profile - Karaka

Joinery - Karaka



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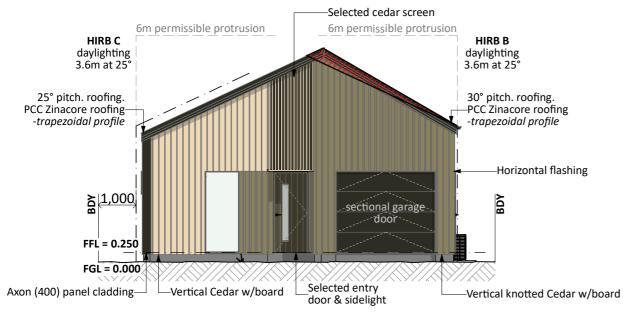


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	Plan:	WT547	Drawn:	EQ: -	^{Client Name:} BARRETT HOMES (CENTRAL OTAGO) LTD	Rev:
	Version:	1.0	Checked: C.	Exposure: _	Site Address: LOT 547	Sheet:
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SOUTH ELEVATION



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ion:	1.0	^{Checked:} C	Exposure:	-	Site Address:	LOT 547
	design@	barretthomes.co.nz	Council:	CODC		WOOING

General Notes:

Any encroachments shown are to be confirmed by a registered surveyor prior to commencement of foundations. No liability shall be held by designer with this confirmation.

NZBC D1/AS1 Access

Minimum slip resistance to steps and landings Concrete or H5 timber step to all access points, min. 150mm below finished floor level

Foundation:

Ribraft floor to Firth specifications (see plan notes and details)

Wall Cladding: JSC Vertical Cedar w/board cladding - J56 profile JH Axon (400) panel cladding JSC Vertical Stained Knotted Cedar w/board cladding - J56 profile

Roof Cladding:

25° pitch. PCC Zinacore roofing - *Trapezoidal profile* 30° pitch. PCC Zinacore roofing - *Trapezoidal profile*

Fascia and Spouting:

COLORCOTE fascia, spouting & 80mm Ø downpipes

Joinery:

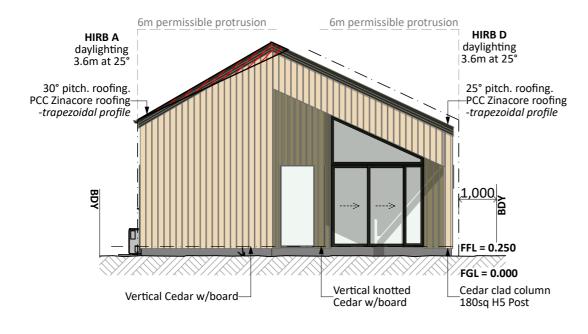
Selected powder coated aluminium joinery

CONCEPT PLAN A consent drawings) Signature	PPROVAL (confirmation to <u>Date</u>
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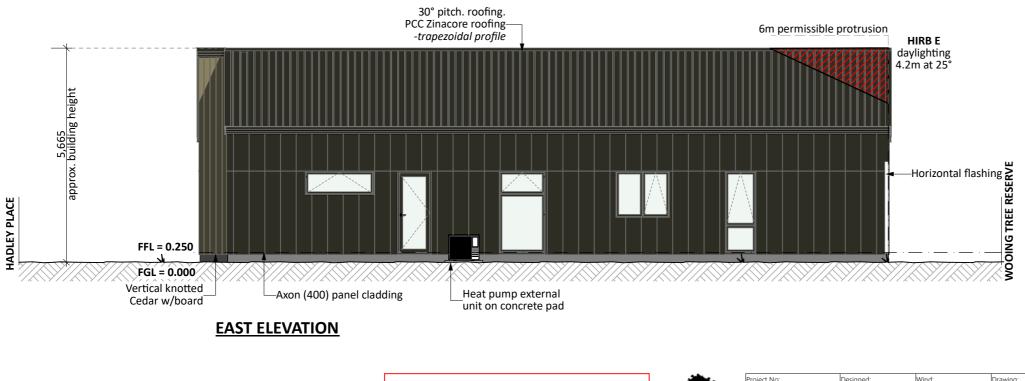
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NING TREE, STAGE 3C, CROMWELL



NORTH ELEVATION



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Barrett Home

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	Version:	1.0	Checked:	CJ	Exposure:	-	Site Address:	LOT 547
es		design@	barretthomes.co	o.nz	Council:	CODC		WOOING 1

General Notes:

Any encroachments shown are to be confirmed by a registered surveyor prior to commencement of foundations. No liability shall be held by designer with this confirmation.

NZBC D1/AS1 Access

Minimum slip resistance to steps and landings Concrete or H5 timber step to all access points, min. 150mm below finished floor level

Foundation:

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Wall Cladding: JSC Vertical Cedar w/board cladding - J56 profile JH Axon (400) panel cladding JSC Vertical Stained Knotted Cedar w/board cladding - J56 profile

Roof Cladding:

25° pitch. PCC Zinacore roofing - *Trapezoidal profile* 30° pitch. PCC Zinacore roofing - *Trapezoidal profile*

Fascia and Spouting:

COLORCOTE fascia, spouting & 80mm Ø downpipes

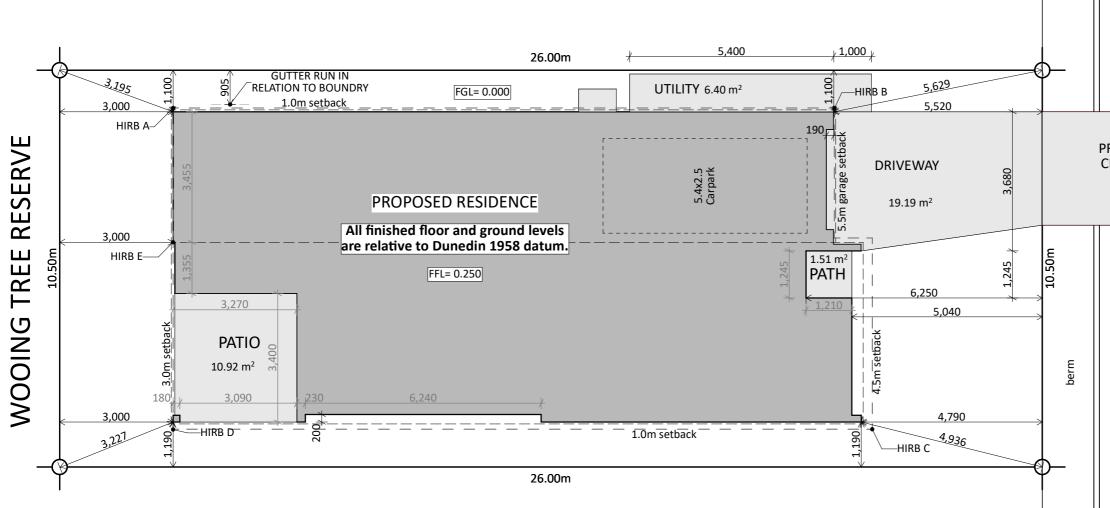
Joinery:

Selected powder coated aluminium joinery

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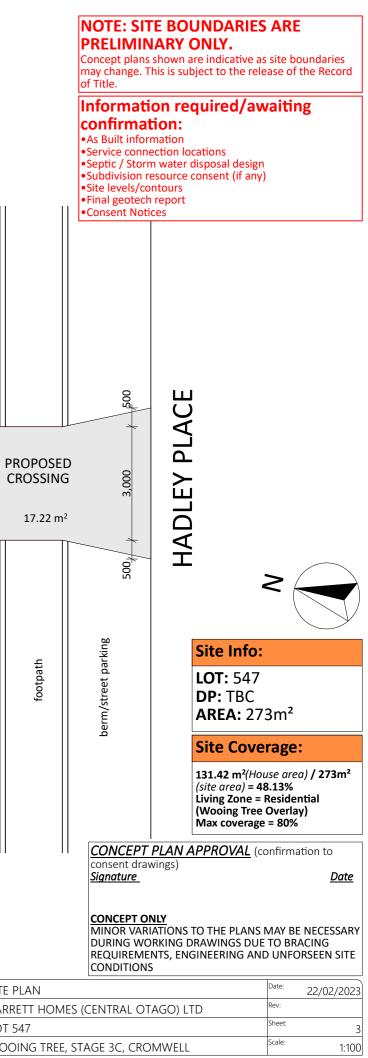
ING TREE, STAGE 3C, CROMWELL

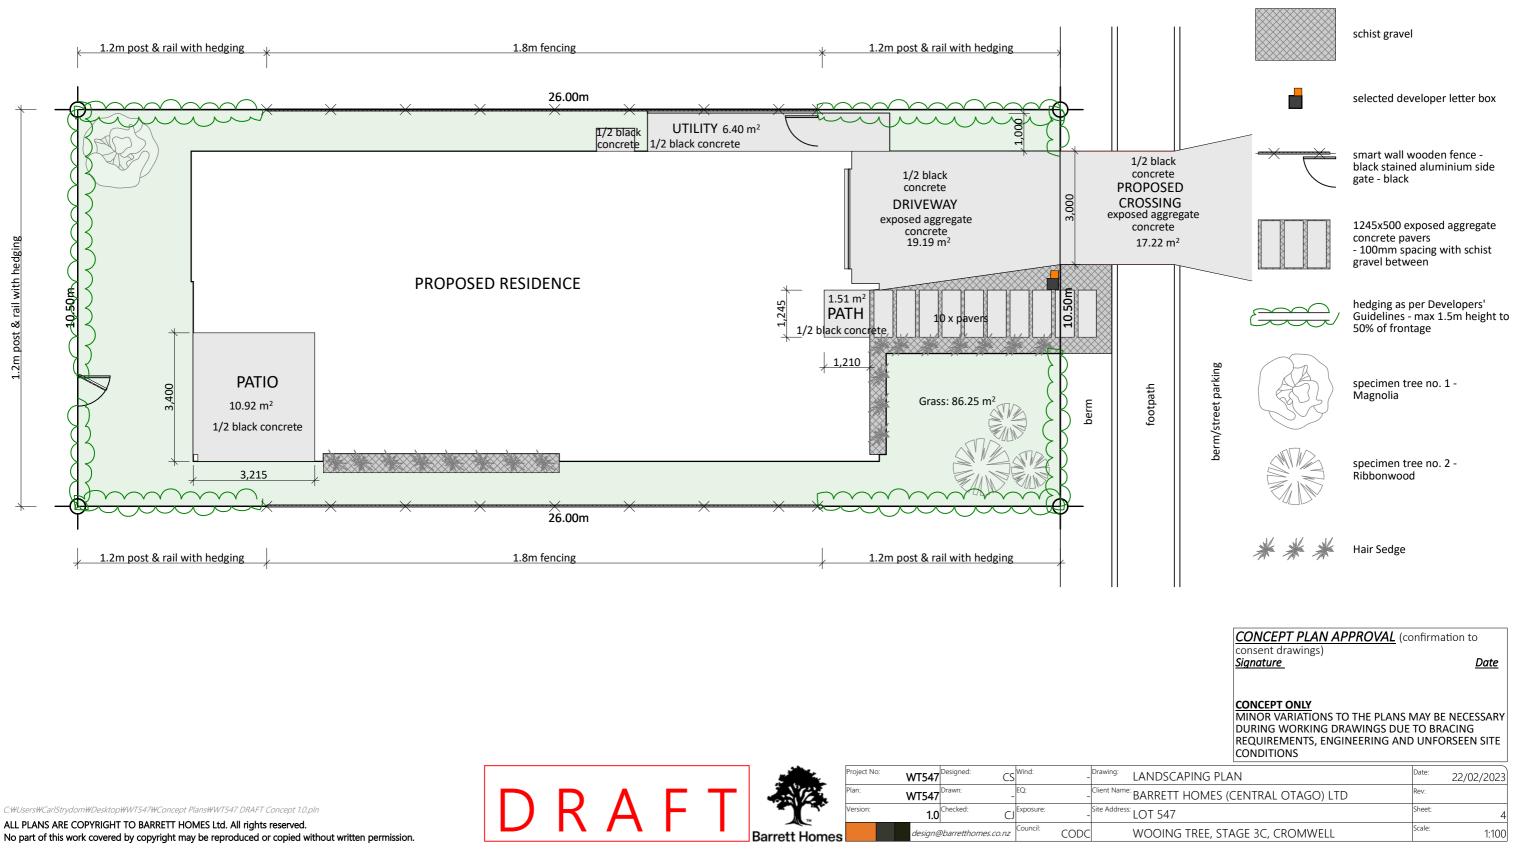


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	Λ		Plan:	WT547	Drawn: -	EQ:	-	Client Name: BARRETT
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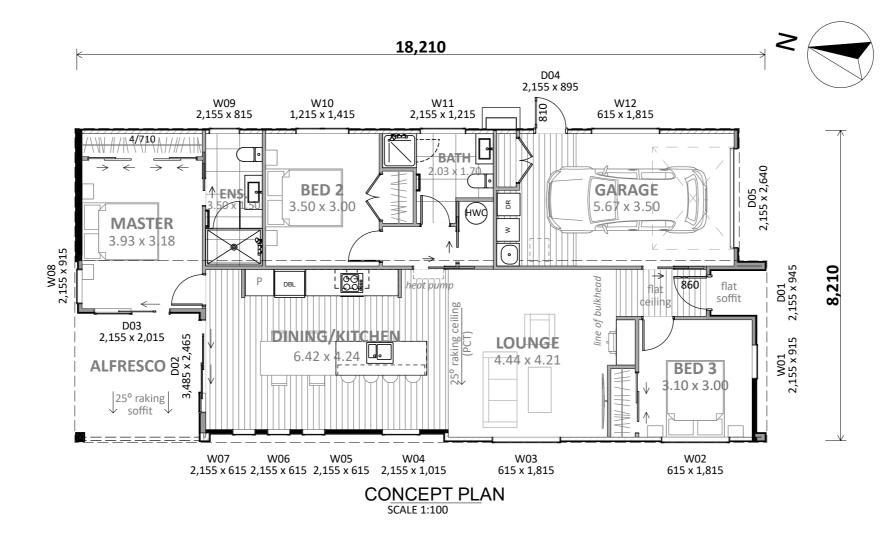
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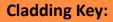


	Project No: WT54	7 ^{Designed:} CS	Wind:	Drawing: CONCEPT PLAN	Date:	22/02/2023
	Plan: WT54	Drawn: -	EQ:	^{Client Name:} BARRETT HOMES (CENTRAL OTAGO) LTD	Rev:	
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Barrett Homes	design	@barretthomes.co.nz	Council: CODC	WOOING TREE, STAGE 3C, CROMWELL	Scale:	

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Plan Notes: 2.425 Stud height throughout All joinery 2155 head height Raking ceiling as shown (PCT) ENGINEERING REQUIRED: - RAKING ALFRESCO PORTAL - GARAGE PORTAL



Knotted Cedar weatherboard

Cedar weatherboard

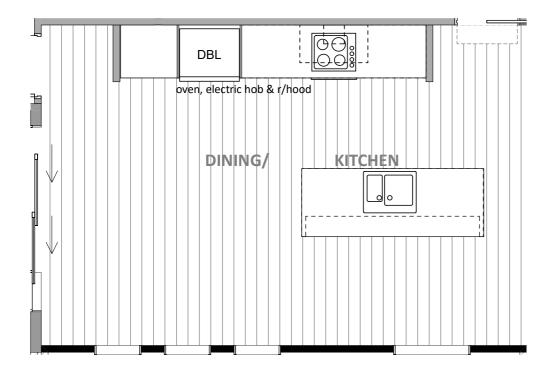
Axon panel cladding

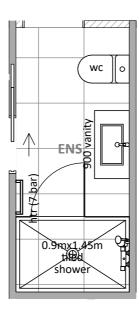
Floor Area:

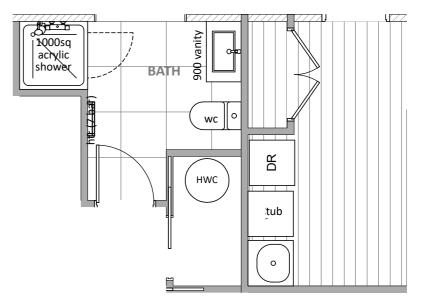
Area o/foundation: 131.42 m²

CONCEPT PLAN APPROVAL (confirmation to consent drawings)
Signature
Date

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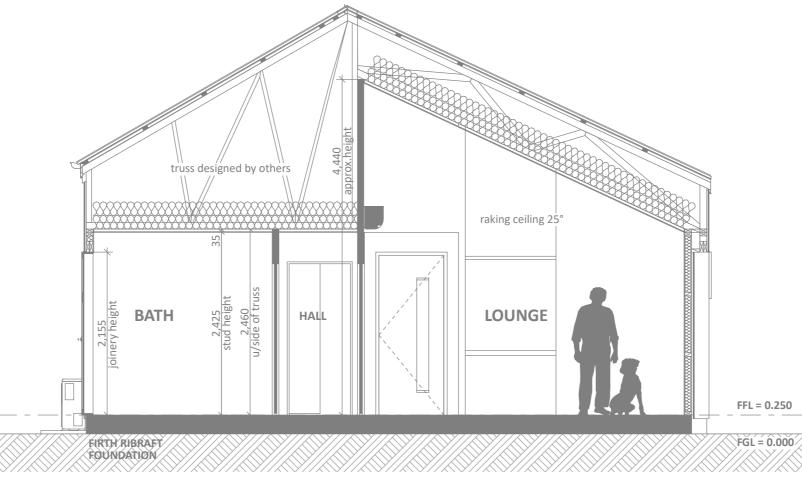


			Project No:	WT547	Designed:	Wind:	Drawing: KITCHEN & BAT
	T.		Plan:	WT547	Drawn:	EQ:	Client Name: BARRETT HOMI
ΚA			Version:	1.0	Checked: C.	Exposure:	Site Address: LOT 547
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Floor Types Key:
= Tiled Floor
= Vinyl Floor
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CROSS SECTION A SCALE 1:50

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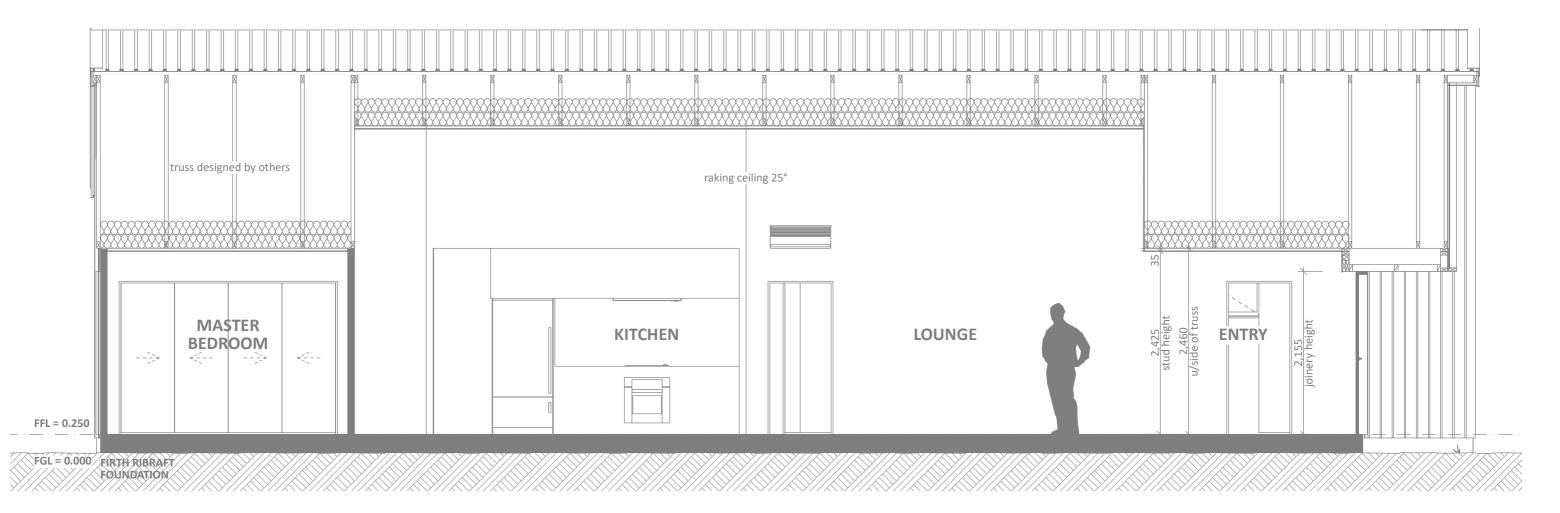
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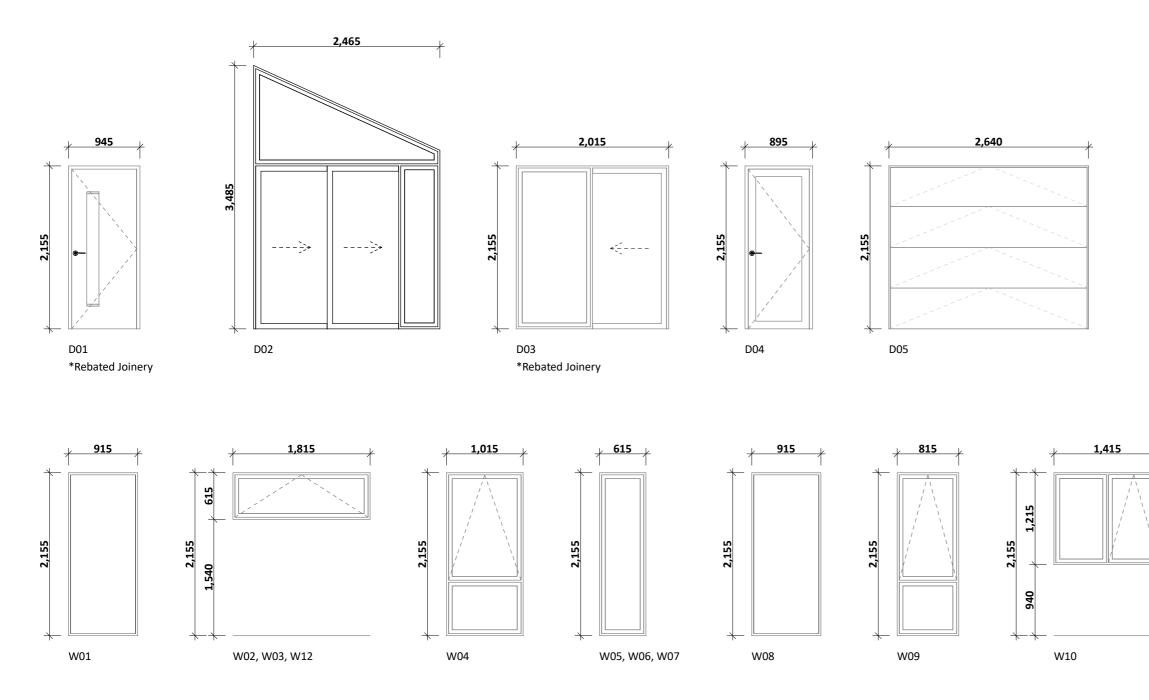
CROSS SECTION B SCALE 1:50



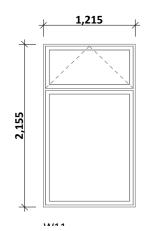
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	CONCEPT PLAN APPROVAL (confirmation to consent drawings)			
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Barrett Home

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General notes:

Aluminium joinery head heights to be 2.155m (excludes rebated joinery units). Refer to floor plan for door & window sizes. Joinery schedule & sizes to be confirmed on site PRIOR to manufacture

Double glazing to all window and door joinery excluding garage (unless specified)

Glazing in accordance with NZS 4223 & 2016 amendments. All glazing clear float unless noted anywhere, (refer to joinery schedule)

- Low level glazing = Any glazing within 800mm from FFL, depending on size and proportions, safety glass or 5mm annealed will be required.

Doors with glazing area > 0.75m² = safety glass
Doors with glazing area < 0.75m² = 5mm annealed
Side panels within 800mm of a door = safety glass, side panels not within 800mm of door considered a window.

sg = Safety glass as required by standards, joinery manufacturer to take precedence ss = Safety stays (in accordance with NZBC:F4 clause 2.0) obsc = Obscure glass

REBATED JOINERY

Rebated joinery sizes are to be confirmed with joinery manufacturer.



CONCEPT PLAN APPROVAL	confirmation to
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